

### COMMUNITY DEVELOPMENT

333 Broadalbin Street SW, PO Box 490, Albany, Oregon 97321-0144 | BUILDING & PLANNING 541-917-7550

# **Notice of Filing**

Site Plan Review

SP-15-23 July 13, 2023

The Planning Division has received the following APPLICATION. Please provide any comments you may have on this project to **Liz Olmstead** at 541-917-7640 or <u>liz.olmstead@cityofalbany.net</u>. The deadline for submission of written comments is 5:00 p.m. on **July 27, 2023**.

### **Application Information**

Proposal: The application requests approval to construct a mobility hub on the existing

circulating roadway at Linn-Benton Community College.

Review Body: Staff (Type I-L review)

Property Owner/ Applicant: Sheldon Flom, Linn Benton Community College, 6500 Pacific Blvd SW,

Albany, OR 97321

Address/Location: 6500 Pacific Blvd SW, Albany, OR 97321

Map/Tax Lot: Linn County Tax Assessor's Map No. 11S-04W-25 Tax Lot 1200

Zoning: Residential Single-Dwelling Unit District (RS-6.5)

Overlay Districts: Riparian Corridor Overlay (not in project area)

Total Land Area: 73.88 acres

Existing Land Use: Institutional – Community College

The City of Albany has received the application for Site Plan Review as referenced above. We are mailing notice of the application to property owners within 100 feet of the proposed development. We invite your written comments on this application to be considered when staff decides on this application. Your comments must relate to the approval standards listed below. Issues that may provide the basis for an appeal to the Planning Commission must be raised in writing and with sufficient detail to allow the City to respond to the issue. The deadline for submission of written comments is 5:00 p.m. on **July 27, 2023**, 14 days from the date the City mails the notice of filing.

We have attached a location map, site plan, and elevation drawings. All application materials are available for review in person at the Planning Division, and copies can be obtained for a minimal charge. Should you wish to discuss this case with a planner, please call **Liz Olmstead**, project planner, at 541-917-7640. Submit any written comments to the Planning Division; PO Box 490, Albany, OR 97321 or by email to <a href="mailto:liz.olmstead@cityofalbany.net">liz.olmstead@cityofalbany.net</a>. Any person submitting written comments will receive a copy of the notice of decision on the application.

According to the Albany Development Code (ADC or Code), the proposed use is allowed on this property. This review is limited to the layout of the proposed use in accordance with the review criteria contained in ADC Section 2.450. The use must also meet applicable City development standards found in the Code.

These standards address such features as off-street parking, landscaping, setbacks, overlay districts, outside storage, and lighting.

The City may attach conditions of approval to the application to ensure that the proposal will conform to the applicable review criteria (ADC 2.450).

### Approval Standards for This Request

### Site Plan Review Criteria

Section 2.450 of the ADC includes the following review criteria that must be met for this application to be approved.


- (1) The application is complete in accordance with the applicable requirements.
- (2) The application complies with all applicable provisions of the underlying zoning district including, but not limited to, setbacks, lot dimensions, density, lot coverage, building height, and other applicable standards.
- (3) Activities and developments within special purpose districts comply with the regulations described in Articles 4 (Airport Approach), 6 (Natural Resources), and 7 (Historic), as applicable.
- (4) The application complies with all applicable Design Standards of Article 8.
- (5) The application complies with all applicable Design Standards of Article 10.
- (6) The application complies with all applicable On-Site Development and Environmental Standards of Article 9.
- (7) The Public Works Director has determined that public facilities and utilities are available to serve the proposed development in accordance with Article 12 or will be made available at the time of development.
- (8) The Public Works Director has determined that transportation improvements are available to serve the proposed development in accordance with Article 12 or will be available at the time of development.
- (9) The proposed post-construction stormwater quality facilities (private and/or public) can accommodate the proposed development, consistent with Title 12 of the Albany Municipal Code.
- (10) The proposal meets all existing conditions of approval for the site or use, as required by prior land use decision(s), as applicable.
- (11) Sites that have lost their nonconforming status must be brought into compliance and may be brought into compliance incrementally in accordance with Section 2.370.

Section 2.455 of the ADC includes additional review criteria for non-residential development that must be met for this application to be approved.

- The transportation system can safely and adequately accommodate the proposed development.
- (2) Parking areas and entrance-exit points are designed to facilitate traffic and pedestrian safety and avoid congestion.
- (3) The design and operating characteristics of the proposed development are reasonably compatible with surrounding development and land uses, and any negative impacts have been sufficiently minimized.

Additional review standards for this Site Plan Review application are found in ADC Articles 1, 2, 3, 6, 8, 9, and 12.

Attachments: Location Map, Site Plan, Elevations

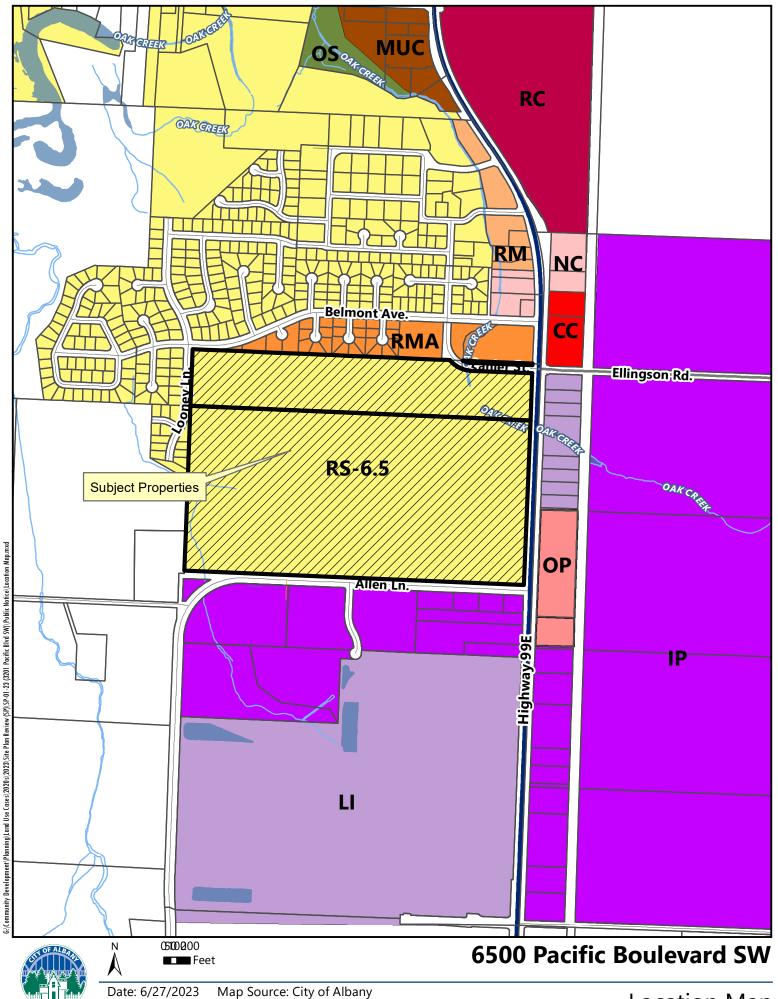


# Riverside Linn-Benton Community College PROJECT LOCATION Fair Mennonite Ch

**VICINITY MAP** 

SHEET INDEX			
SHEET NUMBER	DESCRIPTION		
G1.0	COVER		
D1.0	DEMOLITION PLAN		
EC1.0	EROSION CONTROL PLAN		
C1.0	SITE PLAN		
C2.0	DETAILS		
C2.1	GRADING PLAN		
C2.2	GRADING PLAN		
C2.3	GRADING PLAN		
U1.0	UTILITY PLAN		
ST1.0	SIGNING AND STRIPING PLAN		
A2.0	SHELTER PLAN SECTIONS/ELEVATIONS		
A2.1	RESTROOM PLANS-ELEVATIONS		
A2.2	RESTROOM SECTIONS & DETAILS		
S1.00	GENERAL NOTES		
S2.00	CANOPY PLAN		
S2.10	RESTROOM PLAN		
S3.00	FOUNDATION DETAILS		
S4.00	MASONRY DETAILS		
S5.00	CONNECTION DETAILS		
P0.1	PLUMBING LEGEND		
P0.2	PLUMBING CALCULATIONS		
P1.1	PLUMBING ENLARGED PLANS		
E0.1	ELECTRICAL LEGEND		
E0.2	LUMINAIRE SCHEDULE & LIGHTING MATRIX		
E1.1	ELECTRICAL SITE PLAN		
E2.1	ELECTRICAL ENLARGED PLANS RESTROOM		
E2.2	ELECTRICAL ENLARGED PLANS SHELTER		
E3.1	ONE LINE DIAGRAM & PANEL SCHEDULE		

# LINN-BENTON COMMUNITY COLLEGE MOBILITY HUB

6500 PACIFIC BLVD SW, ALBANY, OR 97321

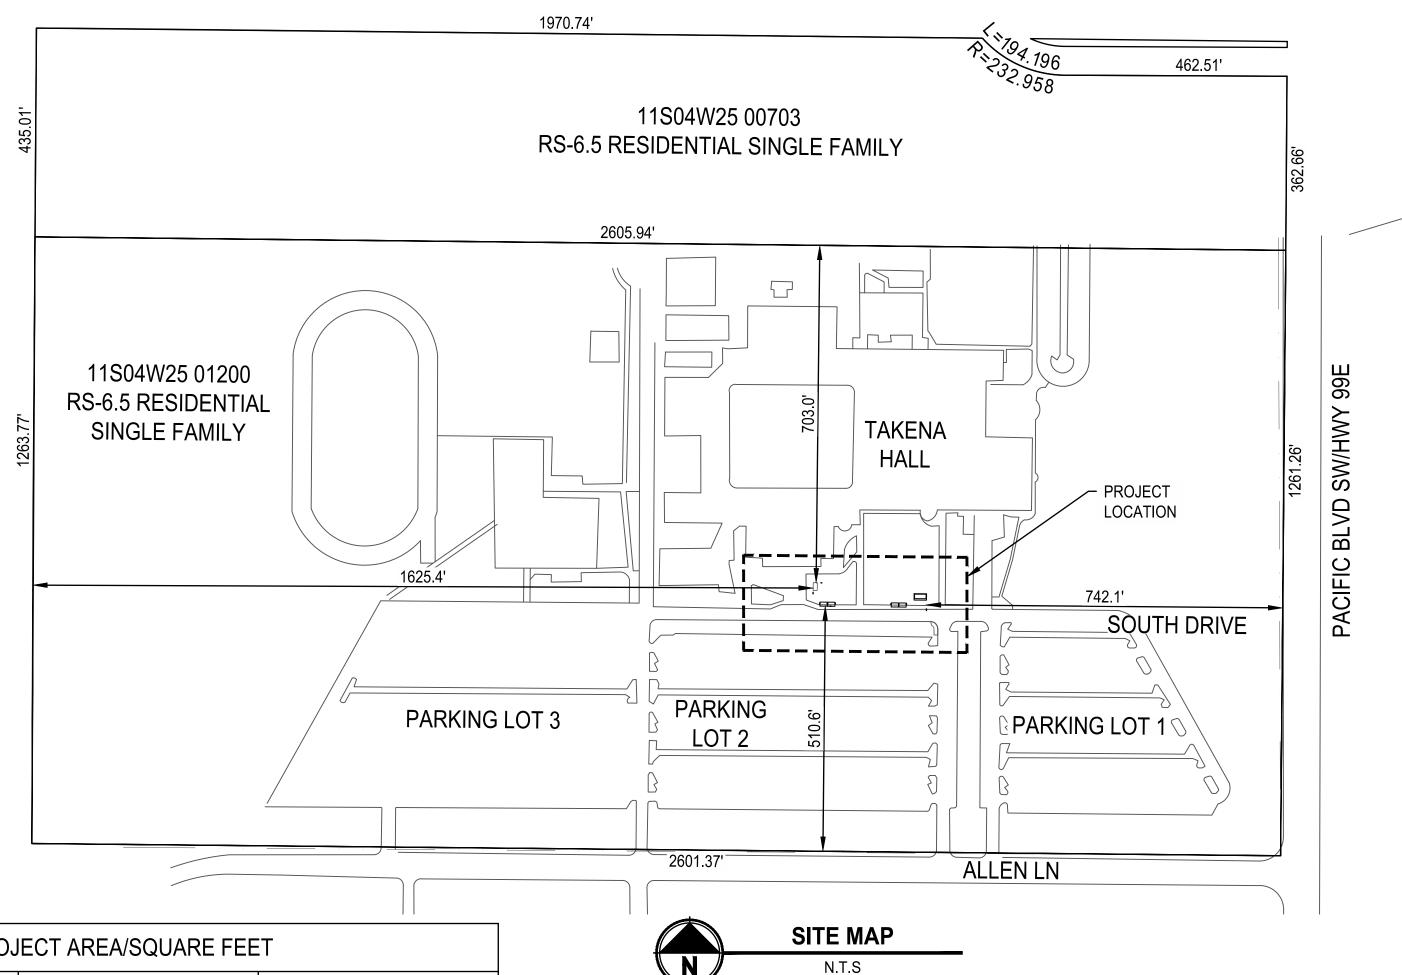

AREAS WITHIN PROJECT AREA/SQUARE FEET			
AREA	EXISTING	PROPOSED	
STRUCTURES (SHLETER/WALKWAY CANOPY, FUTURE MICROMOBILITY SHELTER)	N/A	1,038 SF	
SIDEWALK	157,206 SF	5,650 SF	
ASPHALT (DRIVE AISLES)	772,778 SF	814 SF	
LANDSCAPING/GRASS	1,960,502 SF	2,233 SF	
STORMWATER SWALES	N/A	0 SF	
NEW/REPLACED IMPERVIOUS	N/A	7,076 SF	
TOTAL	2,890,486 SF (TOTAL TAXLOT)	20,543 SF (PROJECT EXTENTS)	

### PROJECT CONTACTS:

CIVIL ENGINEER:
PARAMETRIX
CONTACT: SETH RANKIN, PE
(541) 508-7605
SRANKIN@PARAMETRIX.COM

ARCHITECT:
CONTACT: WATERLEAF
JON STYNER AIA, LEED AP BD+C
(503) 228-7571
JONS@WATERLEAF.COM

STRUCTURAL ENGINEER:
PARAMETRIX
CONTACT: JAKE LINKE, PE
(253) 820-1140
JWLINKE@PARAMETRIX.COM


MECHANICAL/ELECTRICAL ENGINEER:
COLEBREIT/AXIOM
CONTACT: BRUCE JESSUP
(206) 571-8987
BRUCE.JESSUP@COLEBREIT.COM

PLUMBING ENGINEER:
COLEBREIT/AXIOM
CONTACT: MICHAEL LEAVITT
(541) 236-0466
MICHAEL.LEAVITT@COLEBREIT.COM


PLANNING:
URBAN LENS PLANNING
CONTACT: ROBIN SCHOLETZKY, AICP, LEED AP ND
(971) 706-8720
ROBIN@URBANLENSPLANNING.NET


OWNER/APPLICANT:
LINN BENTON COMMUNITY COLLEGE
CONTACT: KEVIN NICHOLSON
(541) 917-4337
NICHOLK@LINNBENTON.EDU



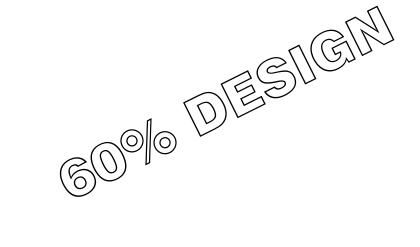



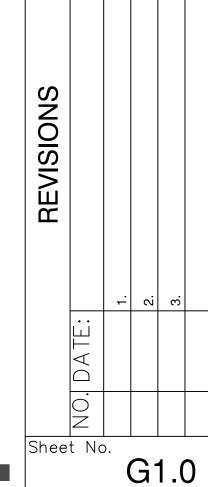

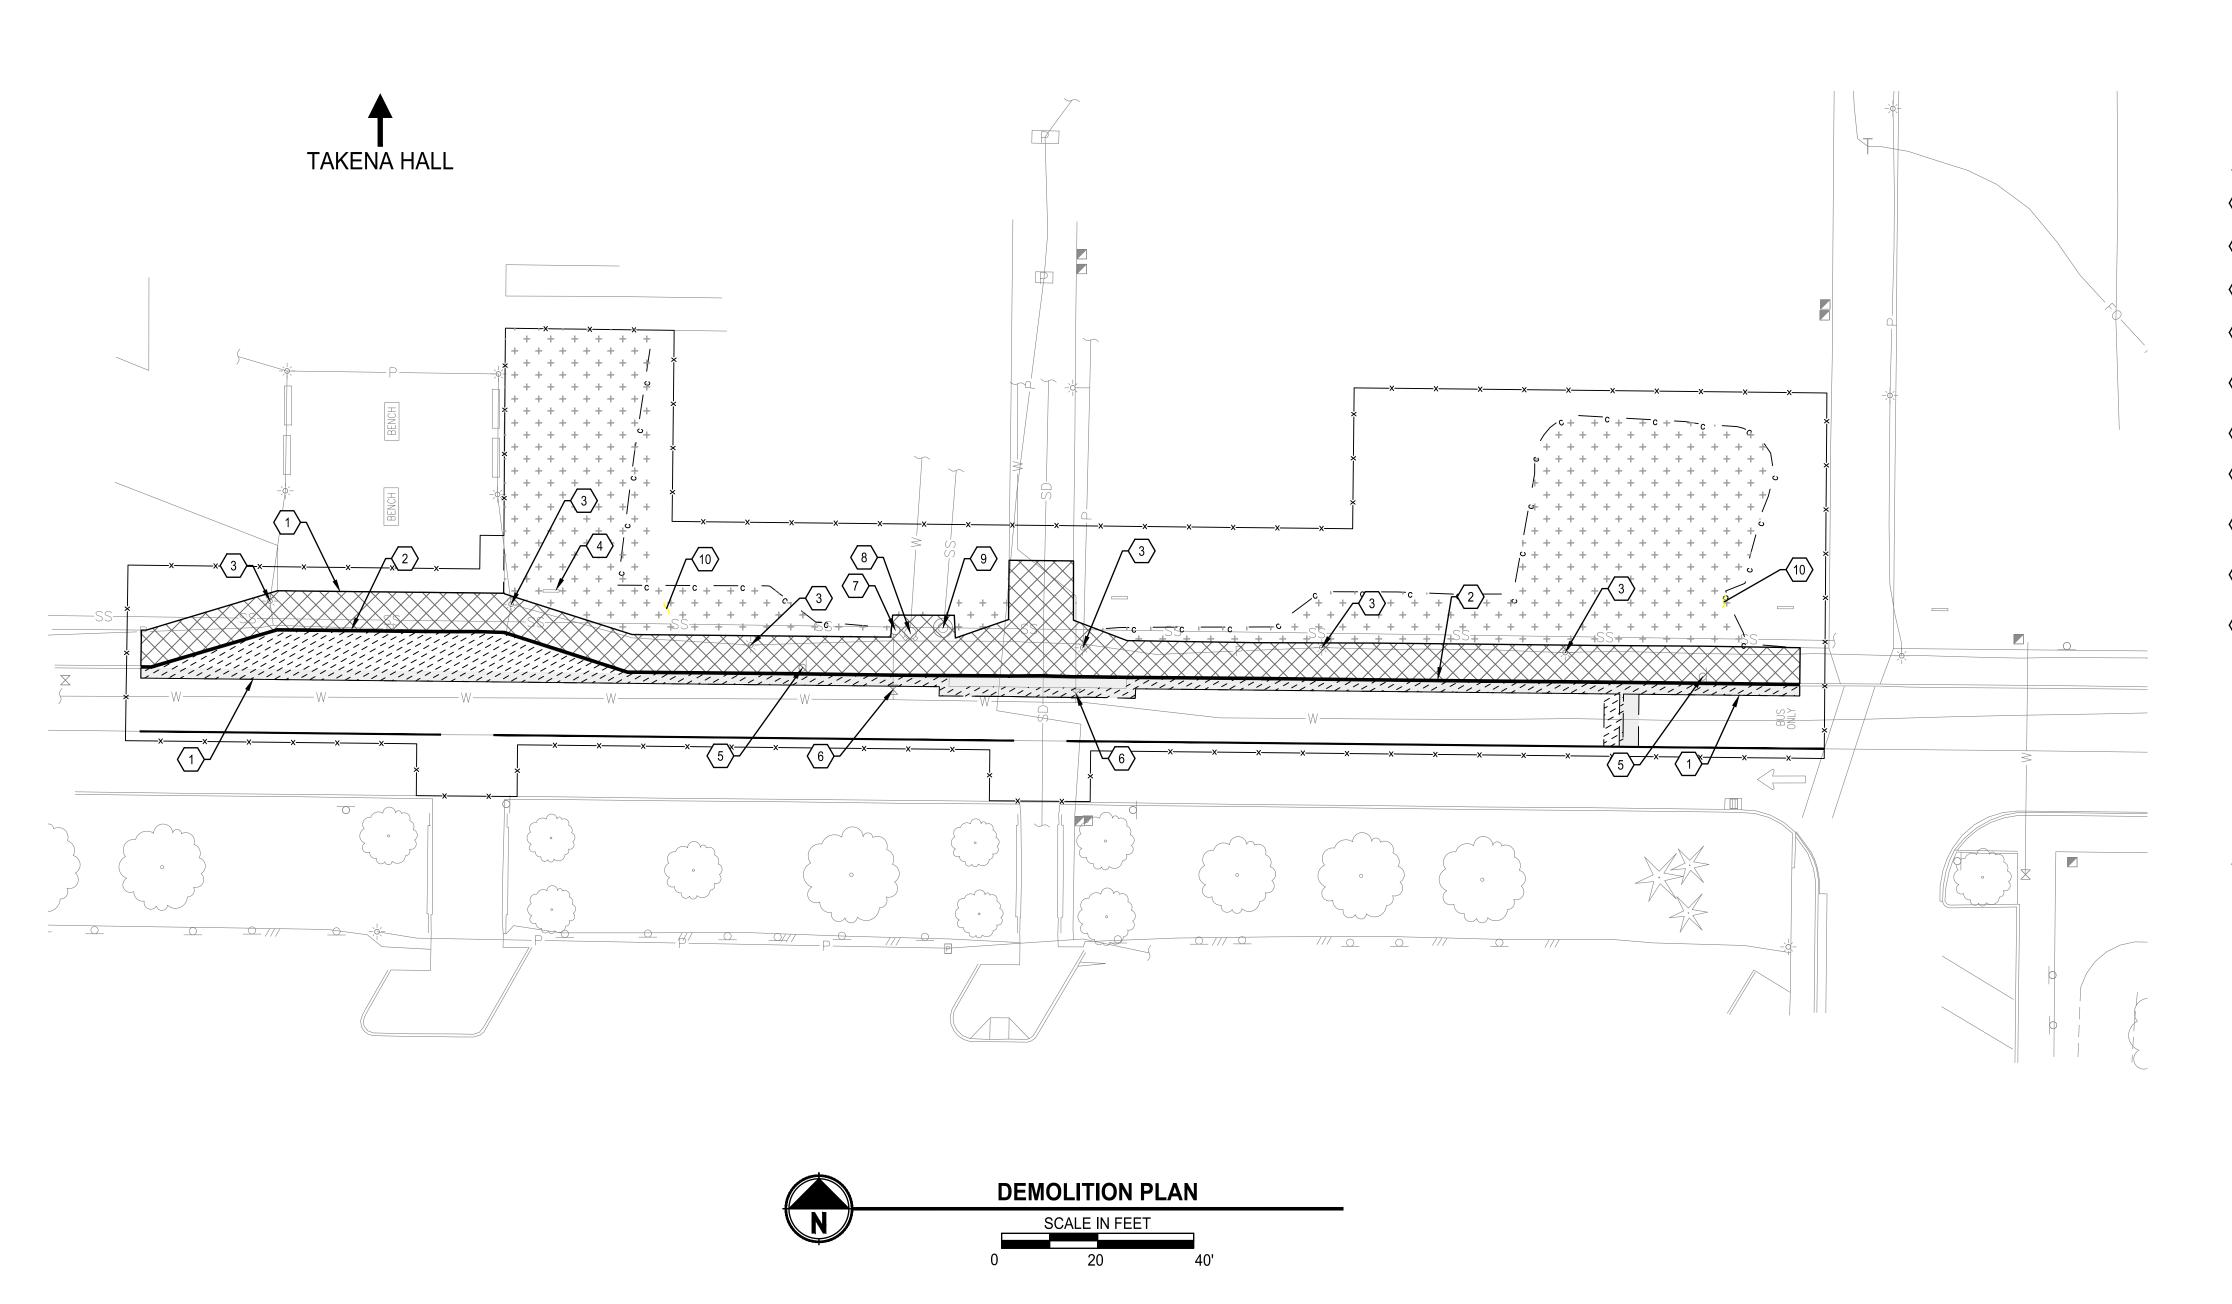

# **GENERAL NOTES:**

- 1. REMOVAL OF EXTG. SURFACES INCLUDING ASPHALT, CONCRETE, SIDEWALKS AND CURBS ARE INCLUDED IN THE GENERAL EXCAVATION QUANTITY.
- 2. ALL CONCRETE CURBS AND SIDEWALK IDENTIFIED FOR REMOVAL SHALL BE REMOVED TO THE CLOSEST CONTROL JOINT, UNLESS OTHERWISE NOTED IN THESE PLANS.
- 3. CONTRACTOR SHALL TAKE ALL NECESSARY PRECAUTIONS TO PROTECT EXISTING UTILITIES, INFRASTRUCTURE, AND IMPROVEMENTS IN PLACE. ANY DAMAGE TO EXISTING FACILITIES OR IMPROVEMENTS, RESULTING FROM THE CONTRACTOR'S OPERATION, SHALL BE REPAIRED OR REPLACED AT CONTRACTOR'S EXPENSE.

### **DEMOLITION NOTES:**

- (1) SAWCUT EXTG. ASPHALT AND CONCRETE SURFACES
- SAWCUT, REMOVE AND DISPOSE OF EXTG. CONCRETE CURB
- (3) REMOVE AND SALVAGE EXTG. LIGHTED BOLLARDS
- REMOVE AND PRESERVE EXTG. BUILDING DIRECTORY FOR REINSTALLATION
- SEE SIGNING AND STRIPING PLAN (SHEET ST1.0) FOR RELOCATION AND REMOVAL OF EXTG. SIGNAGE
- 6 PROTECT EXTG. VALVE AND VALVE BOX IN PLACE
- PROTECT EXTG. HYDRANT ASSEMBLY IN PLACE. SEE SHEETS C2.2 AND U1.0 FOR ADJUSTMENT INFORMATION
- PROTECT EXTG. FIRE DEPARTMENT CONNECTION IN PLACE. SEE SHEETS C2.2 AND U1.0 FOR ADJUSTMENT INFORMATION
- PROTECT EXTG. SANITARY SEWER MANHOLE IN PLACE. SEE SHEETS C2.2 AND U1.0 FOR ADJUSTMENT INFORMATION
- EXTG. IRRIGATION SYSTEM NOT SURVEYED. REMOVE CONFLICTING IRRIGATION SPRINKLER HEADS AND UNDERGROUND IRRIGATION PIPING. CONTRACTOR TO COORDINATE WITH LBCC MAINTENANCE STAFF TO EXTEND COVERAGE AND REPAIR IRRIGATION SYSTEM TO FULLY OPERATIONAL CONDITION

# LEGEND:

EXTG. DECIDUOUS TREE

EXTG. JUNIPER OR CEDAR TREE

CLEARING & GRUBBING

REMOVE EXTG. ASPHALT, BASE MATERIAL AND OTHER CLASSIFIED MATERIAL TO SUBGRADE

REMOVE EXTG. CONCRETE, BASE MATERIAL AND OTHER UNCLASSIFIED MATERIAL TO SUBGRADE

REMOVE EXTG. CURB
PROJECT WORKING EXTENTS

**ASPHALT SAWCUT** 

−c —c − CUT SLOPE

DESIGNI



DEMOLITION PLAN

DEMOLI'S CITY O

CITY OF ALBANY
DEPARTMENT OF COMMUNITY SERVICES
TRANSPORTATION DIVISION
333 BROADALBIN ST SW, ALBANY, OR 97321

ATE:


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Sheet No.

D1.0



### **GENERAL NOTES:**

- 1. SEE GRADING AND DRAINAGE SHEETS FOR GRADING INFORMATION AND ADDITIONAL DETAILS
- 2. SEE SHEET ST1.0 FOR SIGNING AND STRIPING DETAILS
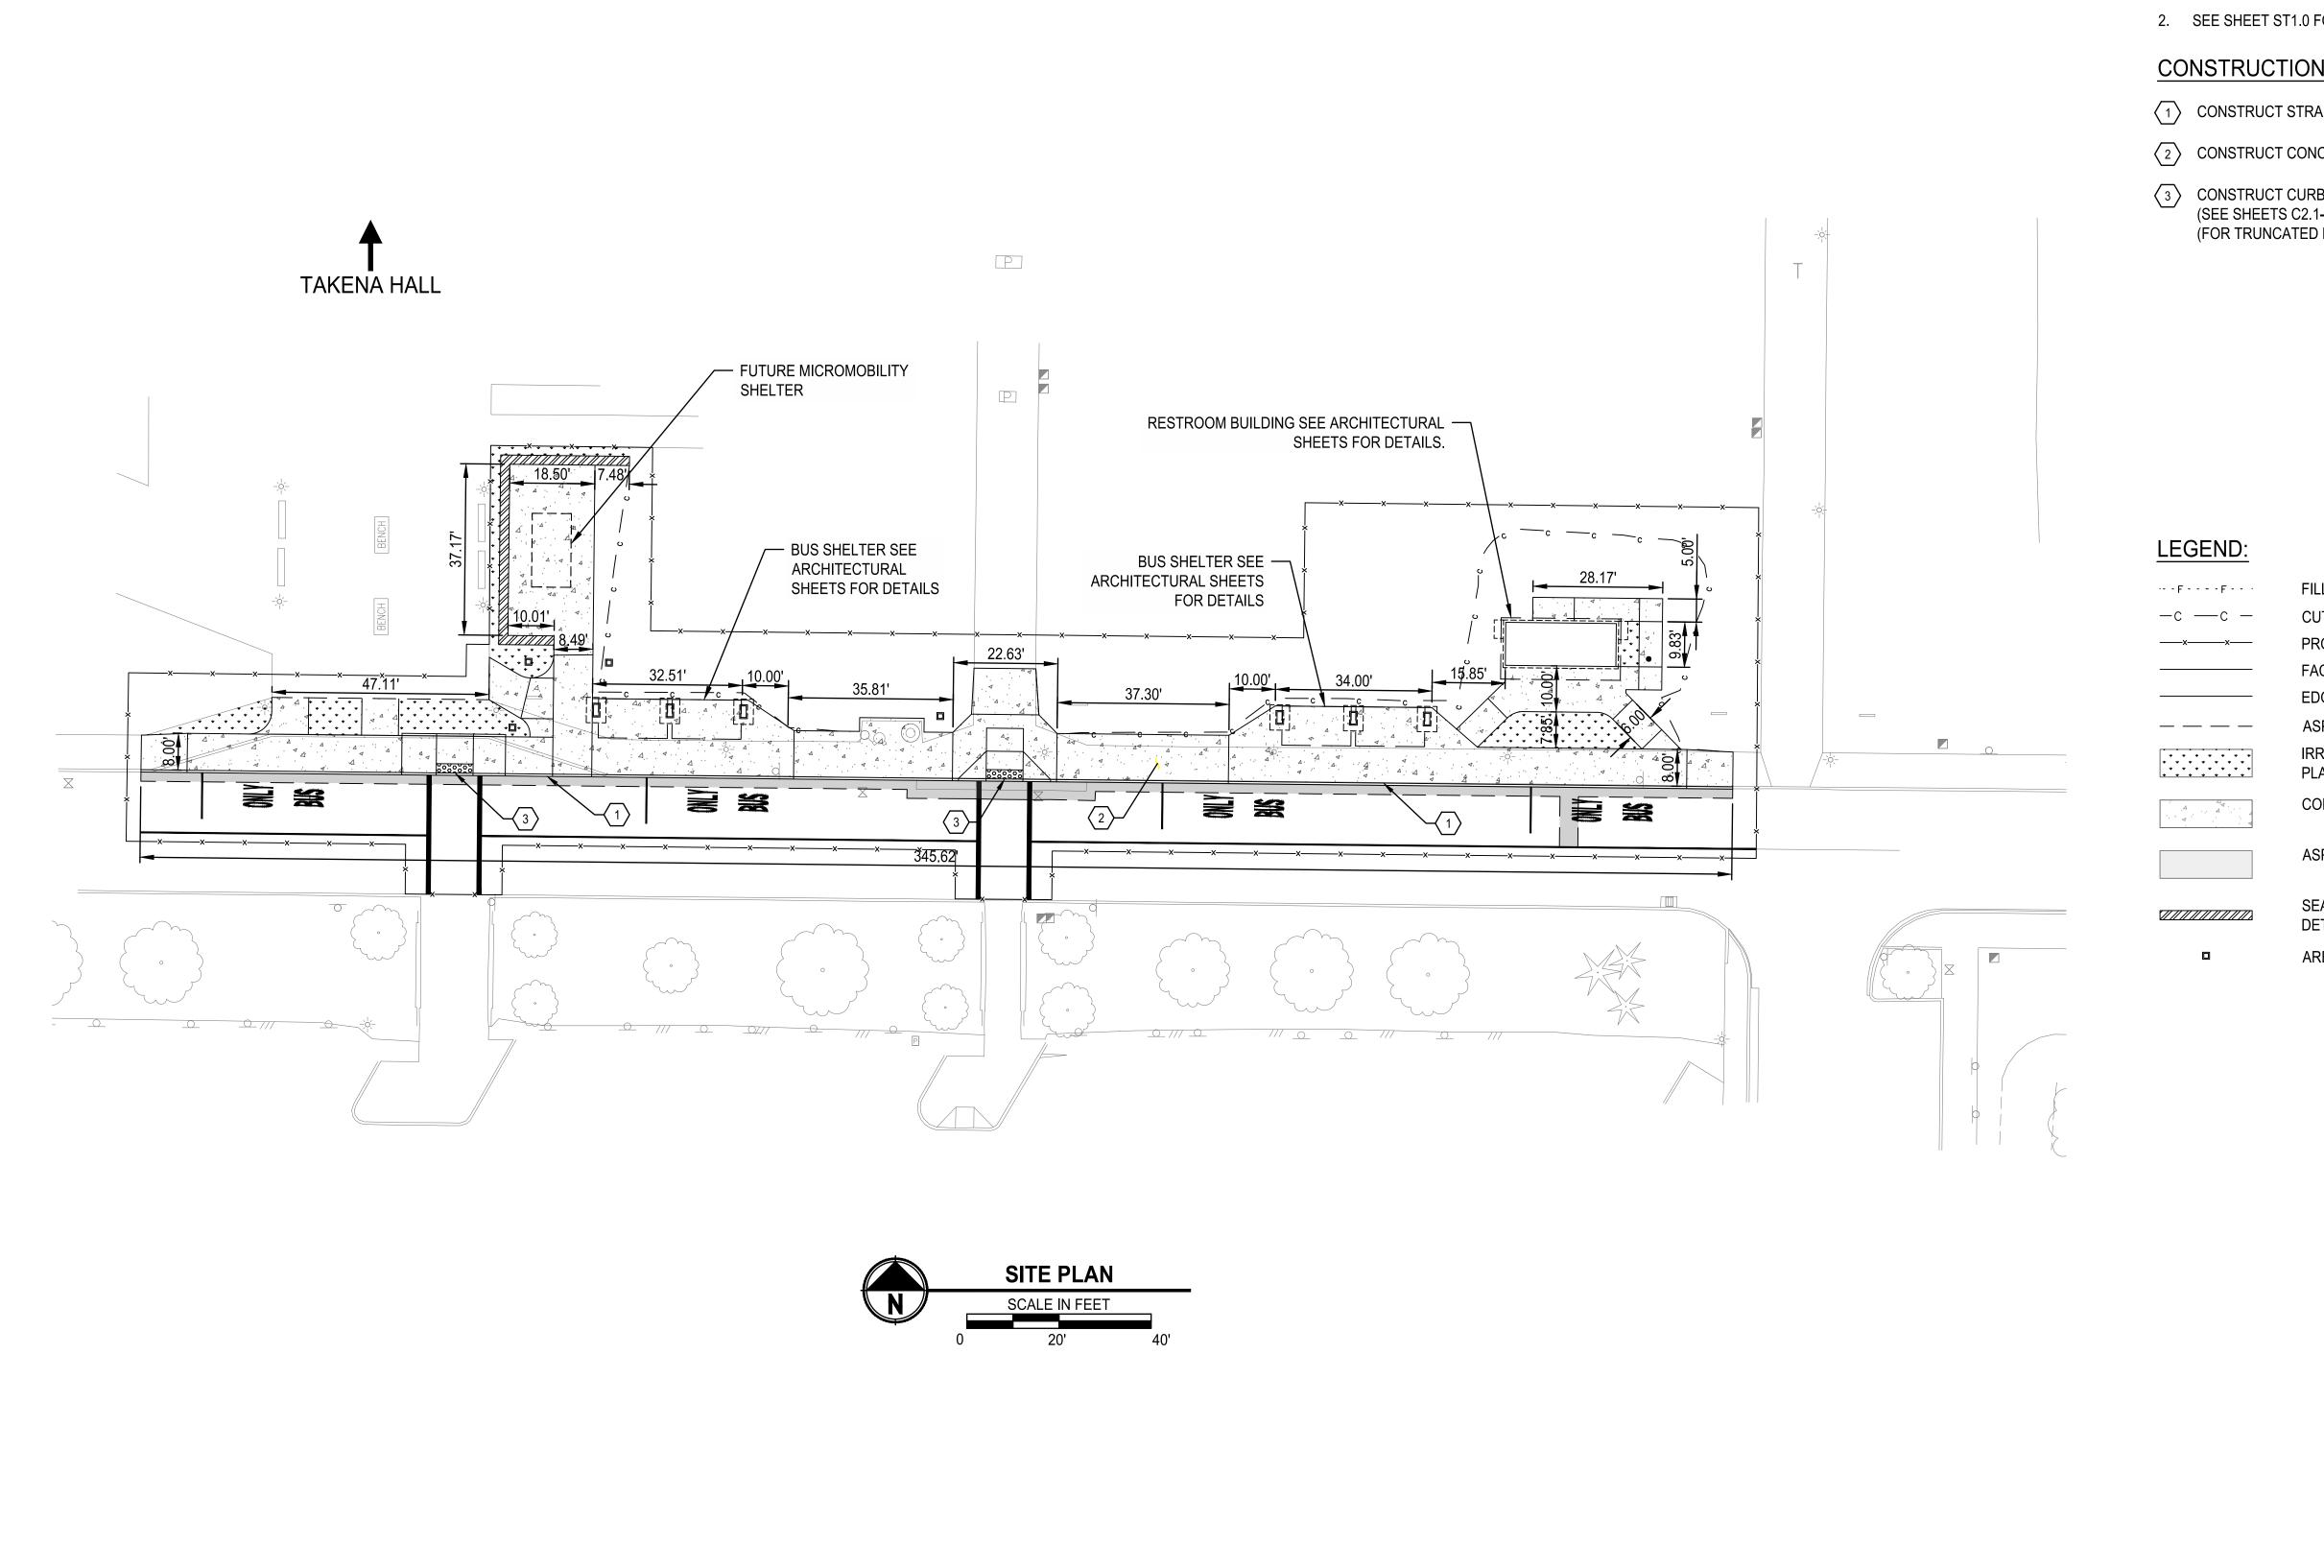
# **CONSTRUCTION NOTES:**

- (1) CONSTRUCT STRAIGHT CURB PER DETAIL 2 ON SHEET C2.0
- 2 CONSTRUCT CONCRETE SIDEWALK PER DETAIL 4 ON SHEET C2.0
- (3) CONSTRUCT CURB RAMP (SEE SHEETS C2.1-C2.3 FOR GRADING DETAILS) (FOR TRUNCATED DOME DETAILS, SEE ODOT STD. DWG. RD759)

FILL SLOPE

CUT SLOPE

PROJECT WORKING EXTENTS FACE/BACK OF CURB

EDGE OF CONCRETE WALK

ASPHALT SAWCUT

IRRIGATED LANDSCAPING AREA (SEE LANDSCAPING PLAN TO BE PROVIDED WITH 90% SUBMITTAL)

CONCRETE SIDEWALK

ASPHALT PAVING (SEE SHEET C2.0 FOR DETAILS)

SEAT WALL. SEE ARCHITECTURAL PLANS FOR

AREA DRAIN - SEE GRADING PLANS FOR DETAILS

Parametrix
ENGINEERING . PLANNING . ENVIRONMENTAL SCIENCES


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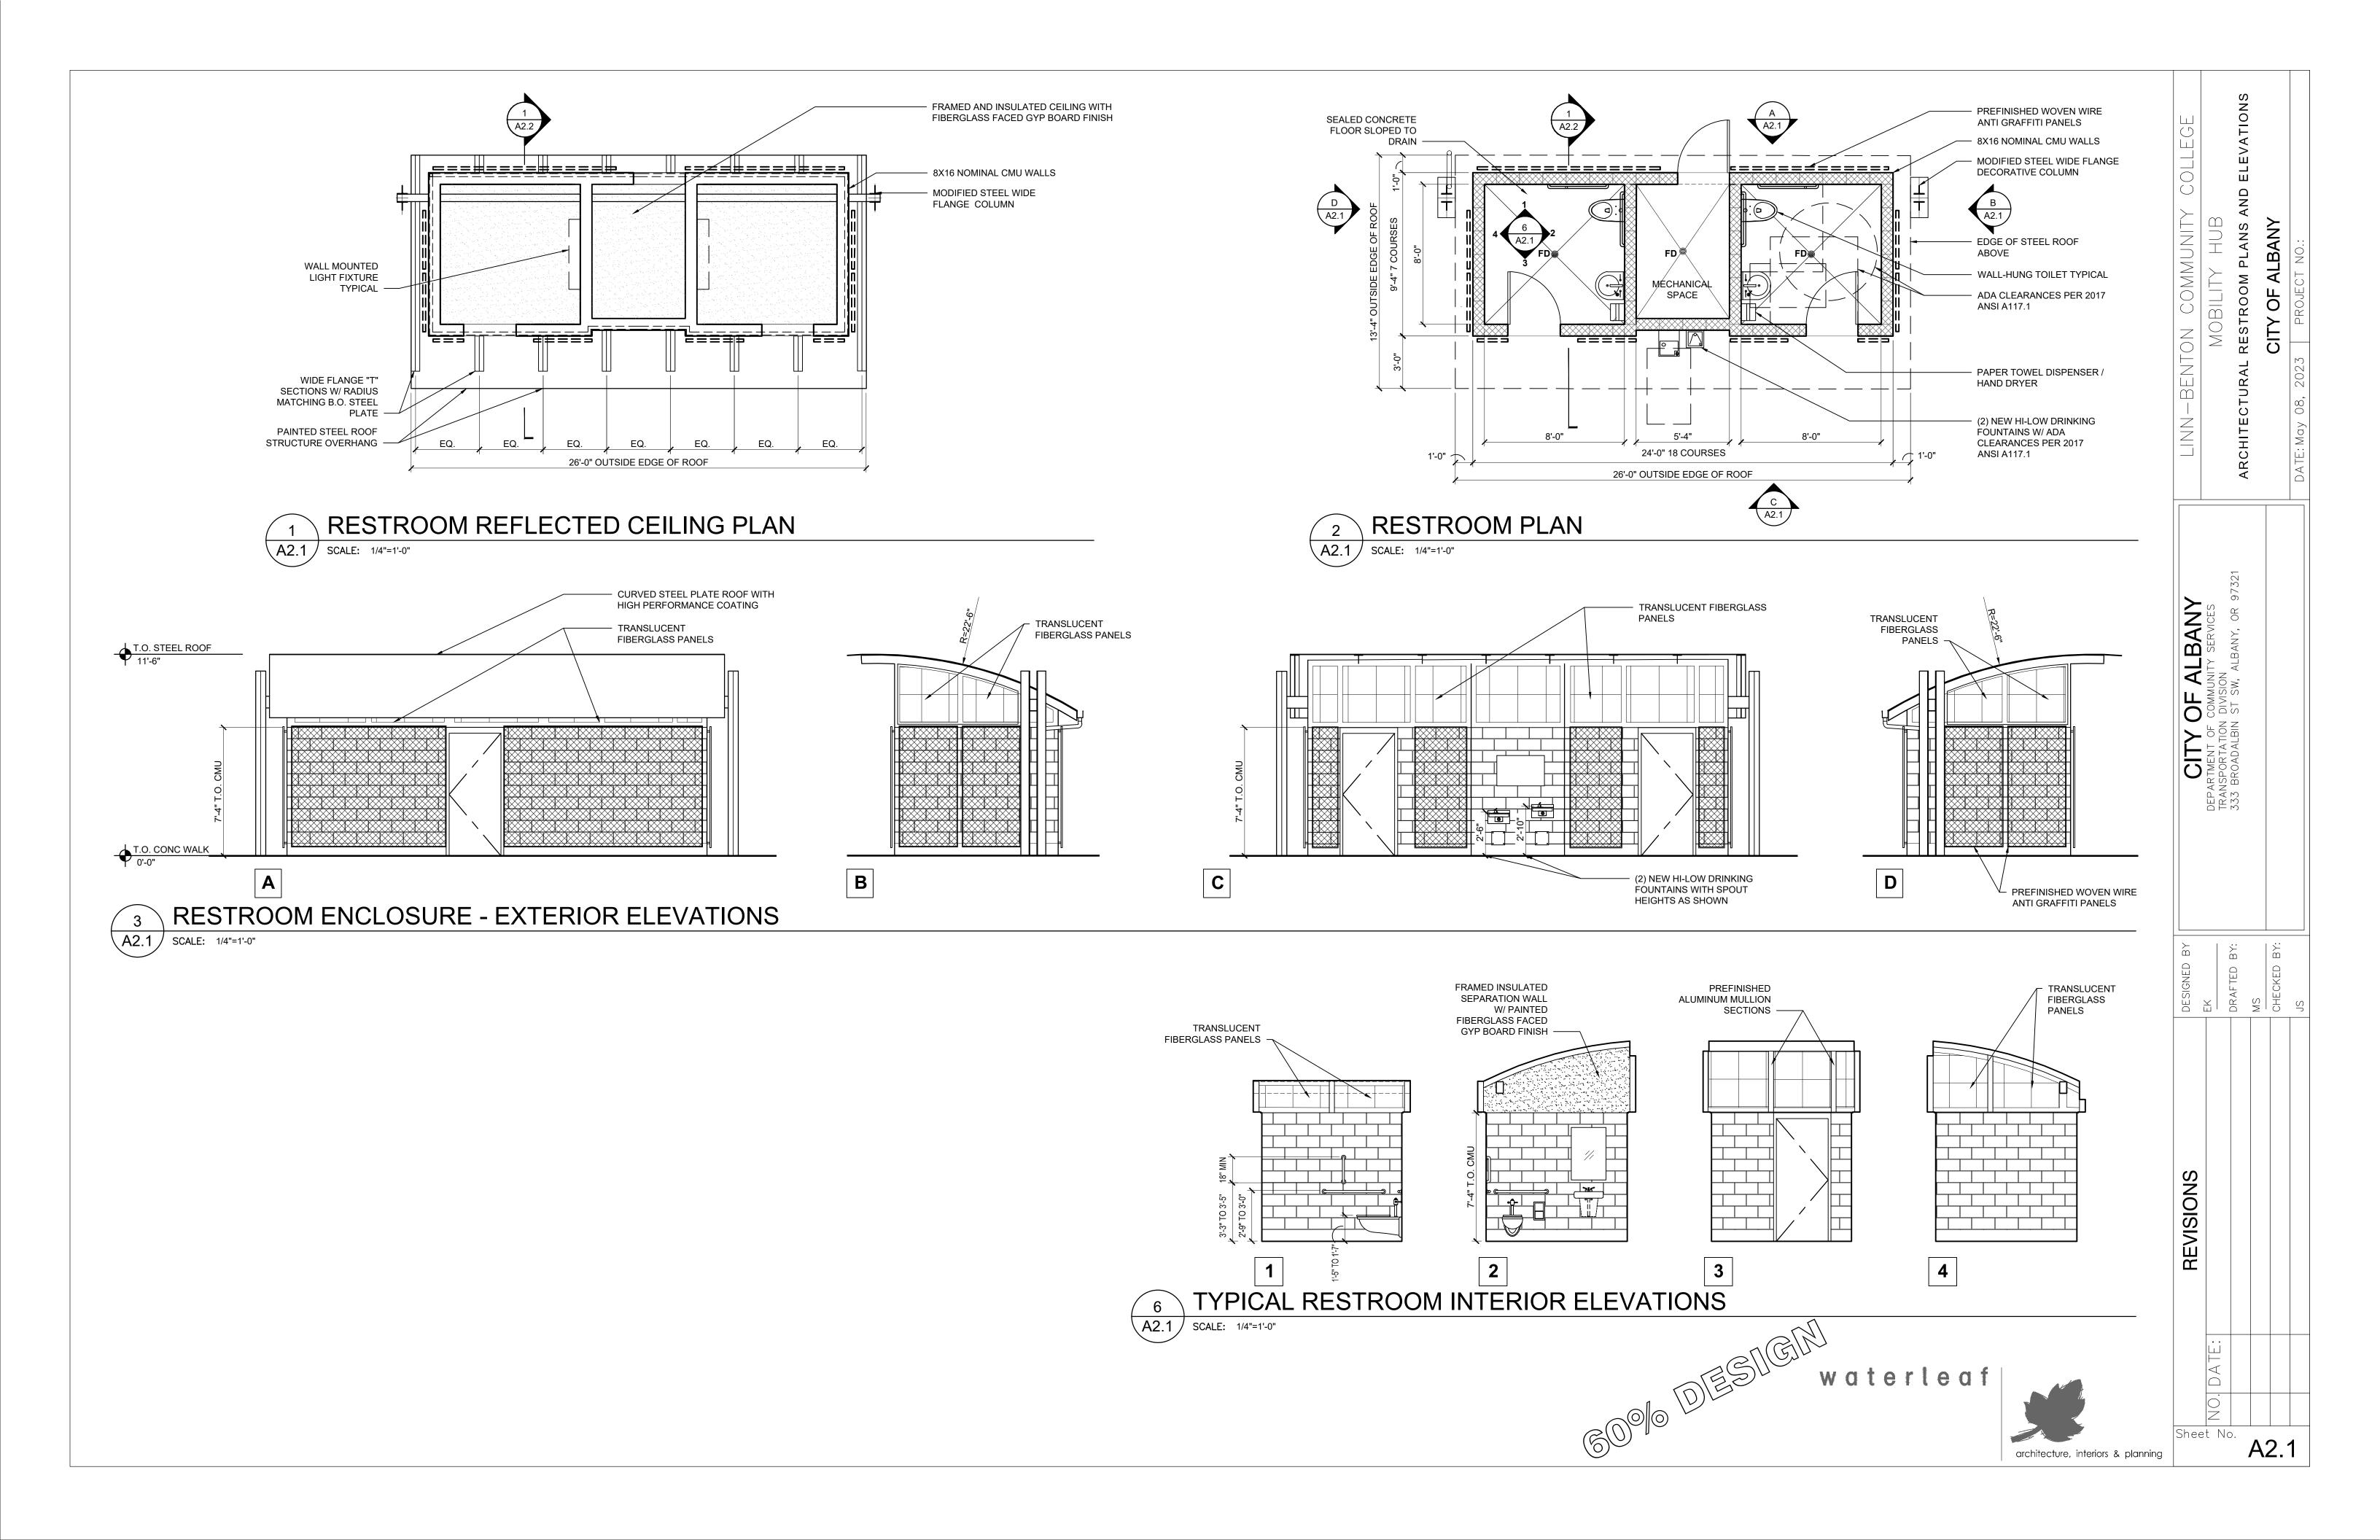
SITE


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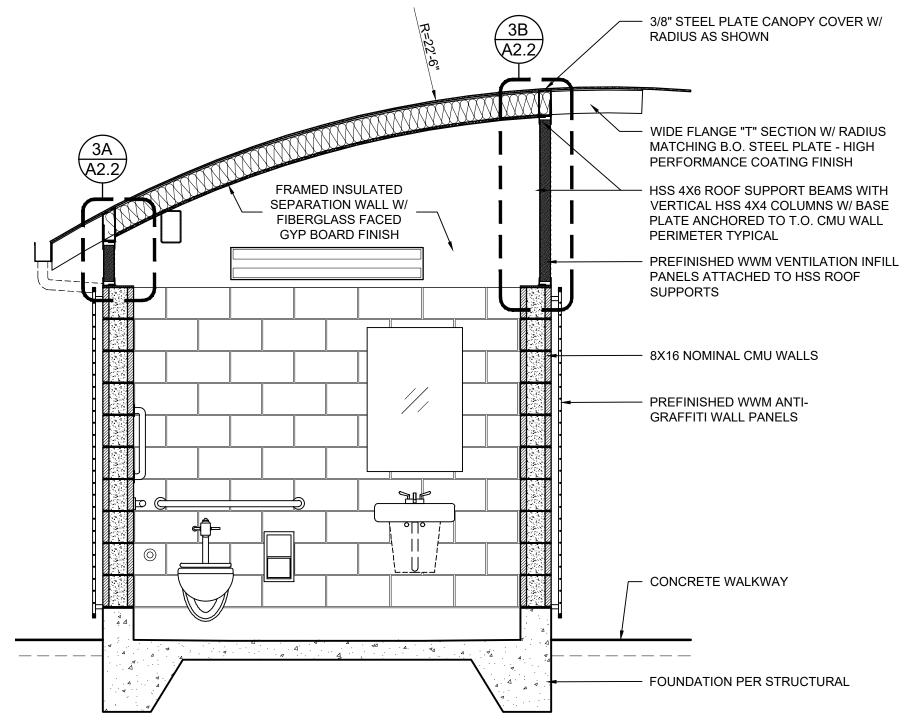
NO. DATE

Sheet No. C1.0






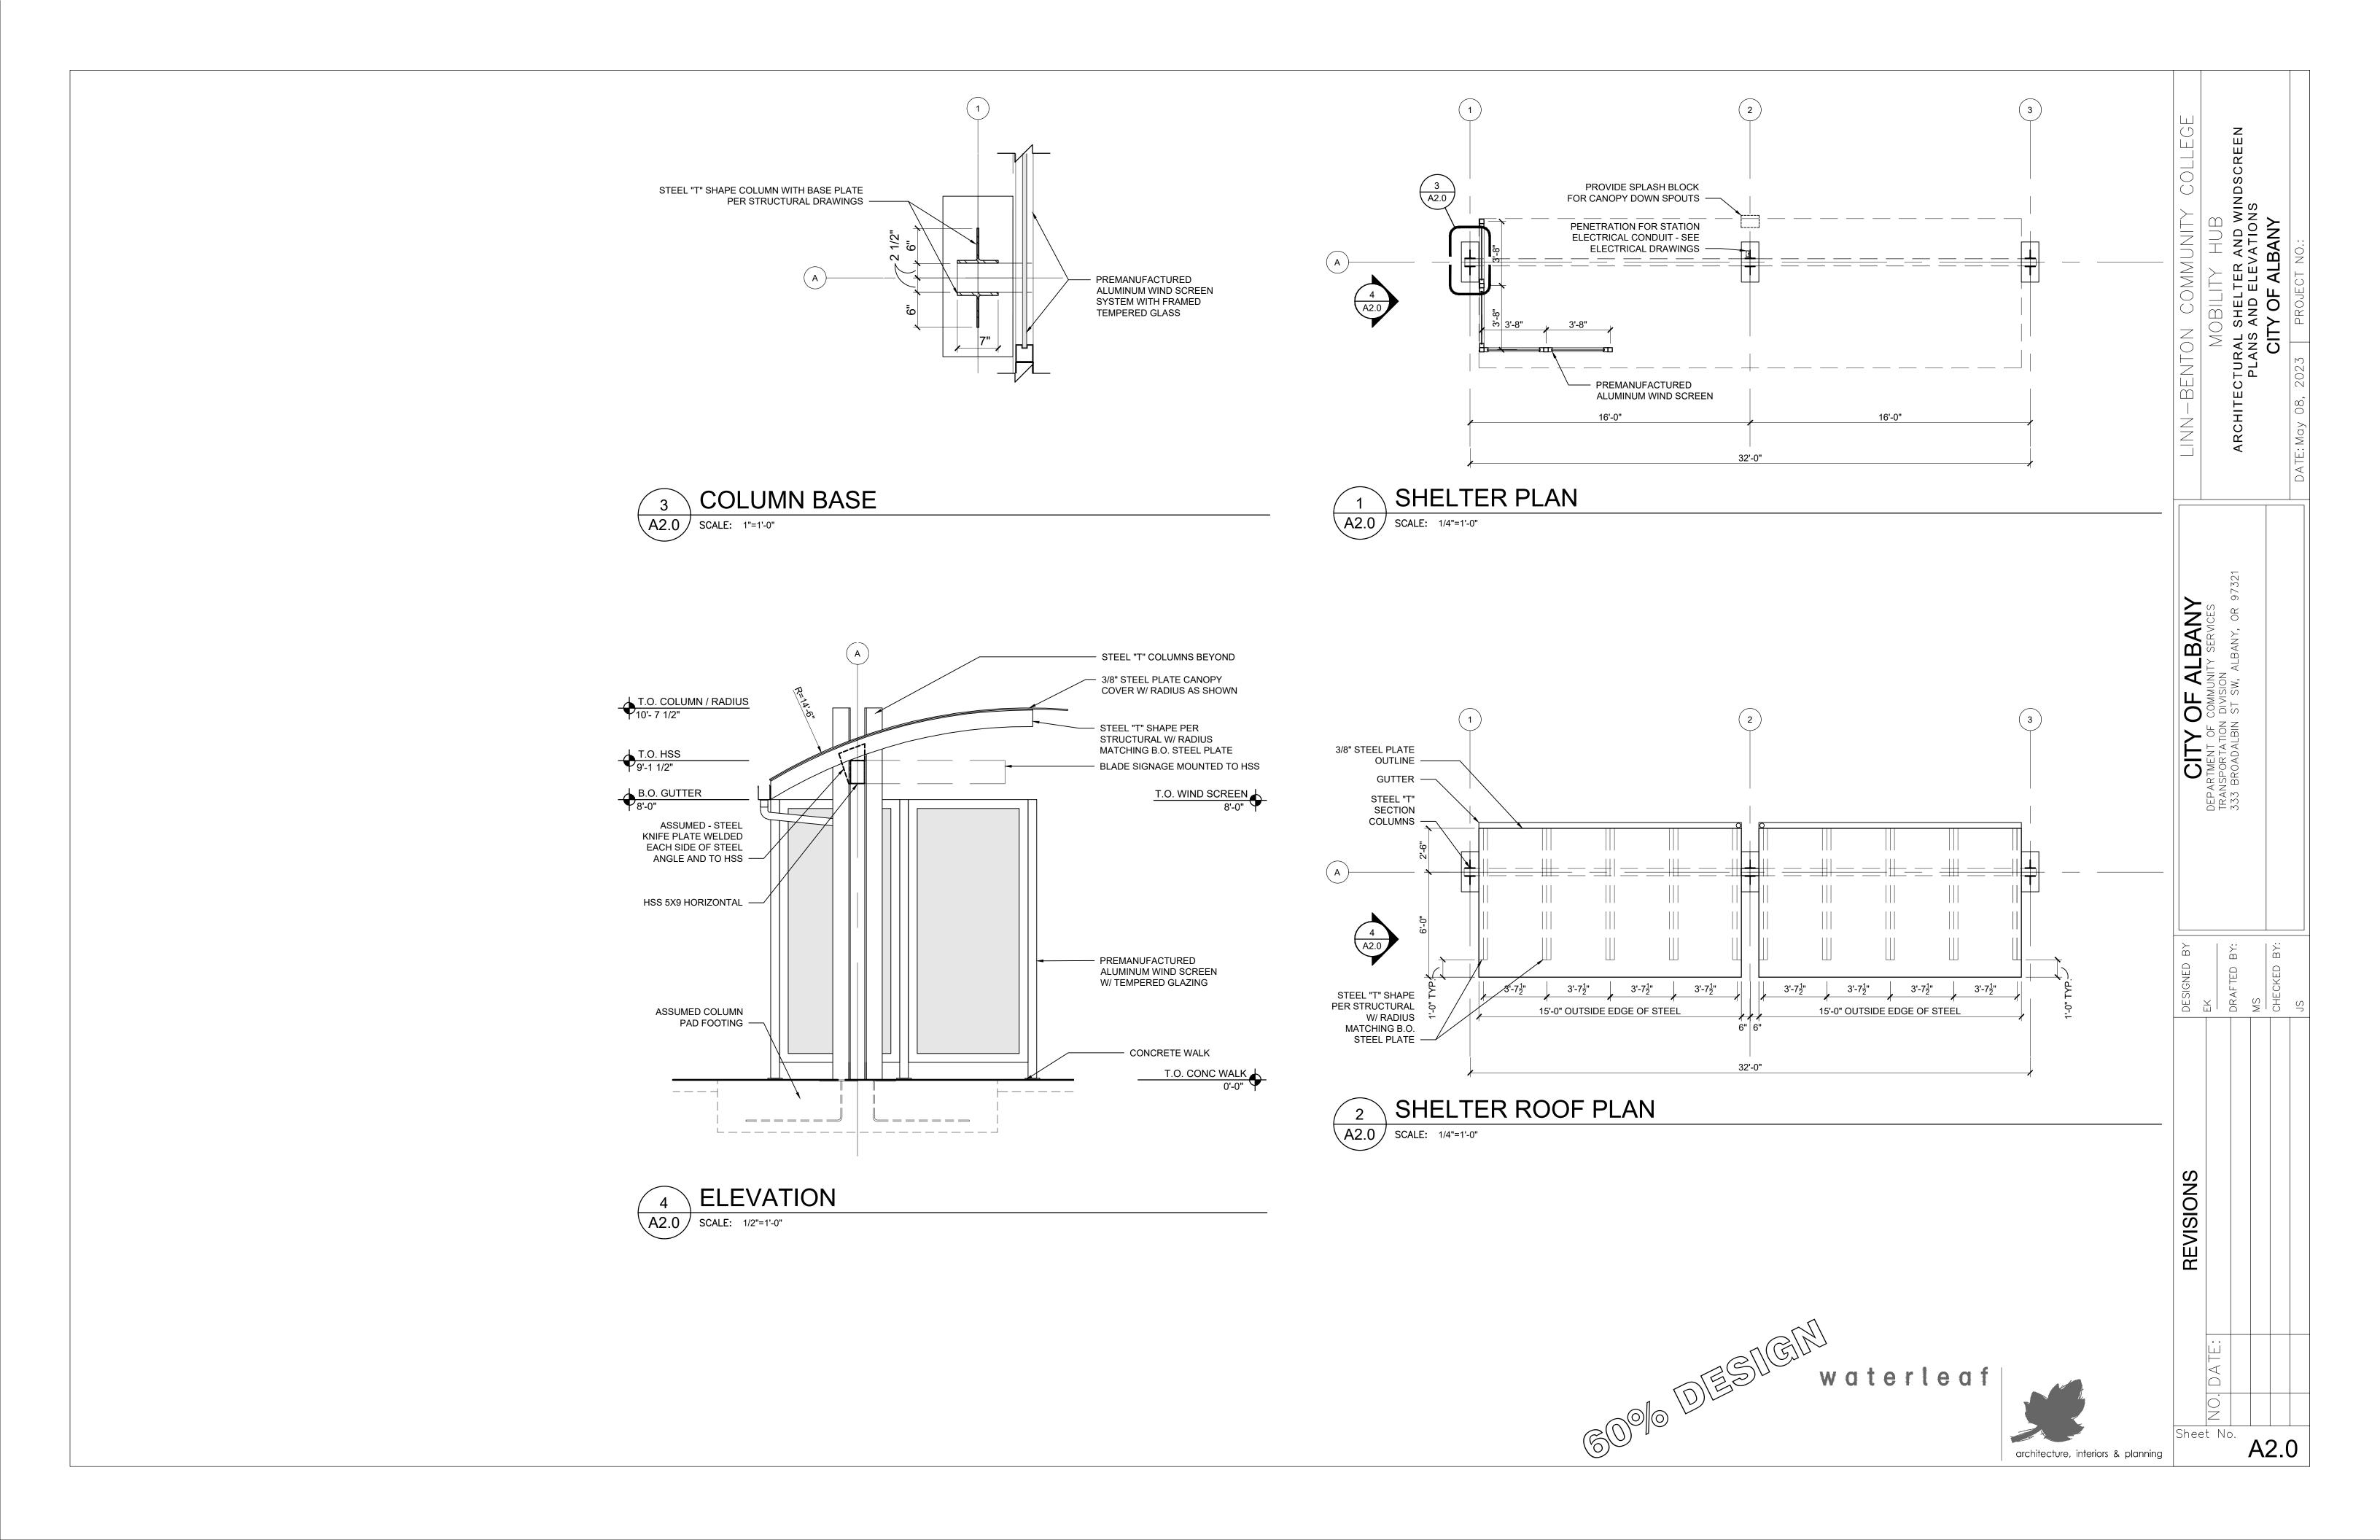

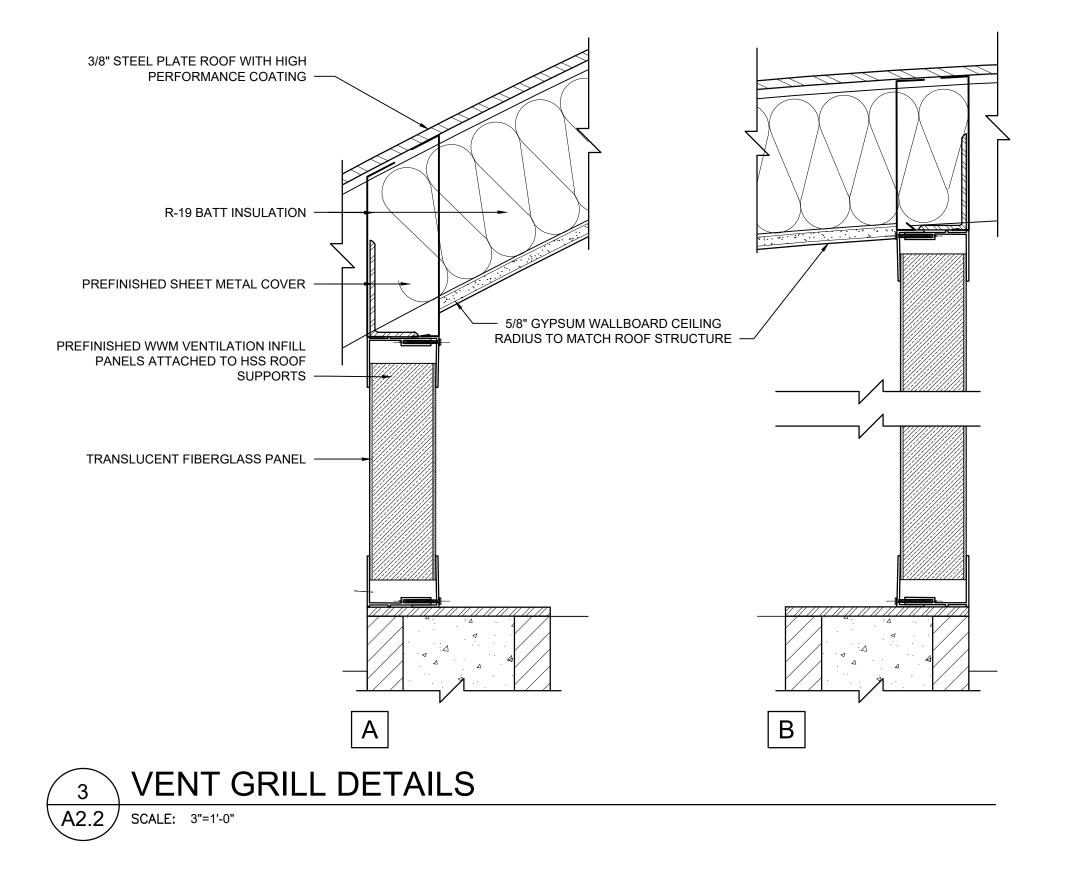

RESTROOM SECTION A2.2 SCALE: 1/2"=1'-0"

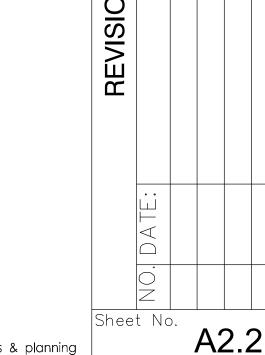

DE

AND

RESTROOM

ALBANY

OF ALBANY

architecture, interiors & planning